
INDEX OF SHEETS
SEE SHEET 2

MARYLAND DEPARTMENT OF TRANSPORTATION

## STATE HIGHWAY ADMINISTRATION


# **S.H.A. CONTRACT NO. – TA2295133** FEDERAL AID PROJECT NO. -MD 33 (TALBOT STREET) – FROM 200' NORTH OF LEE STREET TO 150' SOUTH OF SPENCER DRIVE

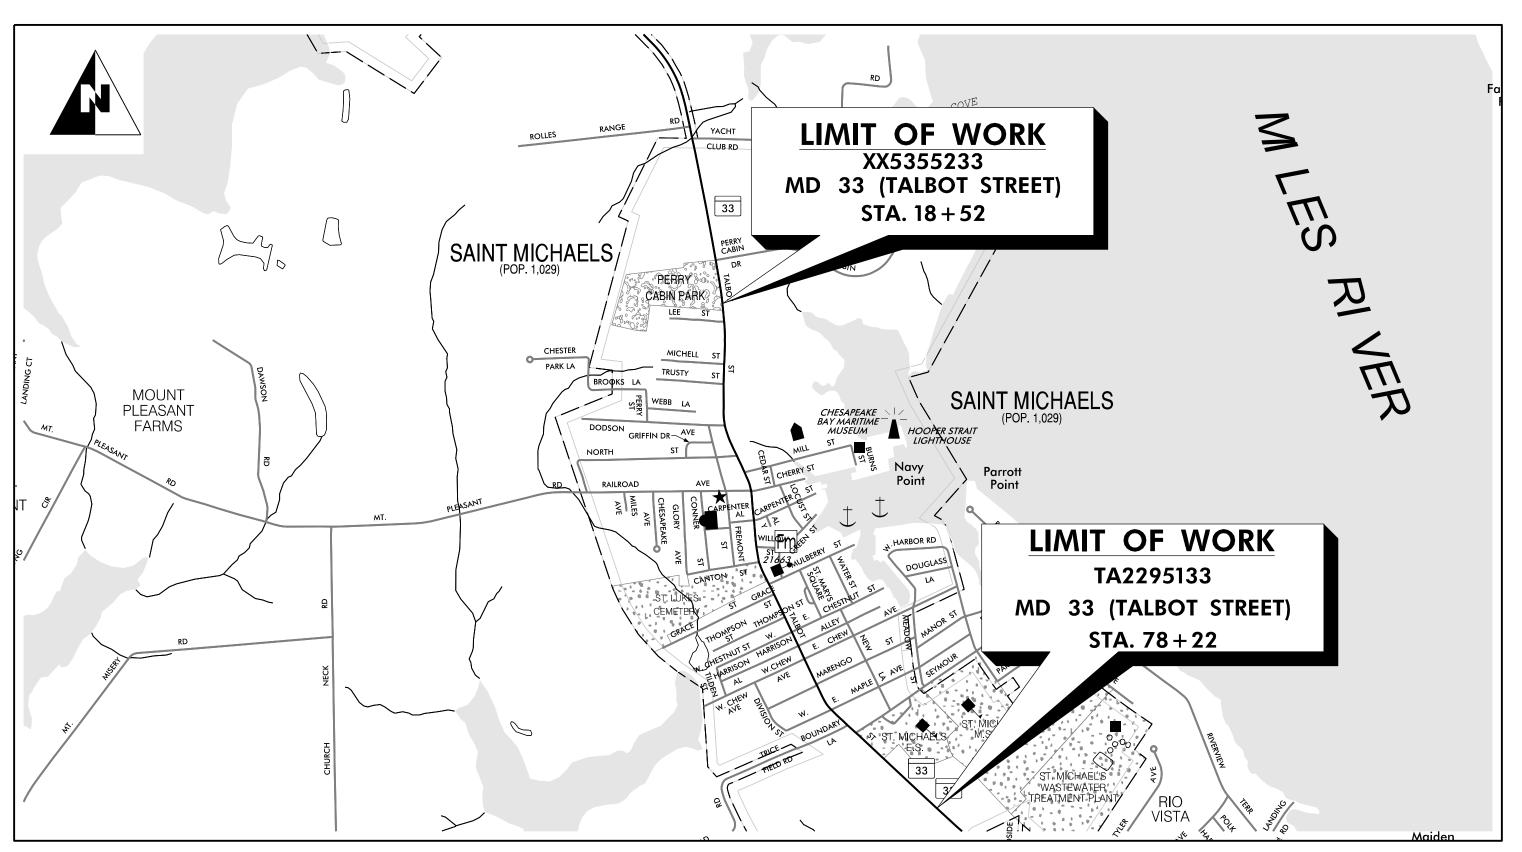

TALBOT COUNTY, SAINT MICHAELS

HORIZONTAL DATUM	NAD	83 /91
VERTICAL DATUM	NAD	88

#### LENGTH OF PROJECT: MD RTE. 33 = 1.131 MILES

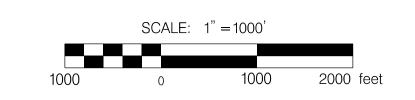

THIS PROJECT WAS DESIGNED IN ACCORDANCE WITH THE 2018 PUBLICATION OF AMERICAN ASSOCIATION OF STATE HIGHWAY AND TRANSPORTATION OFFICIALS (AASHTO) "A POLICY ON GEOMETRIC DESIGN OF HIGHWAYS AND STREETS".

#### STANDARD SPECIFICATIONS BOOK, BOOK OF STANDARDS AND MANUAL ON UNIFORM TRAFFIC CONTROL DEVICES (MUTCD)

ALL WORK ON THIS PROJECT SHALL CONFORM TO: THE LATEST APPROVED MARYLAND DEPARTMENT OF TRANSPORTATION STATE HIGHWAY ADMINISTRATION (MDOT SHA) "STANDARD SPECIFICATIONS FOR CONSTRUCTION AND MATERIALS" REVISIONS THEREOF OR ADDITIONS THERETO, AS INDICATED IN THE PROJECT DESCRIPTION OF THE INVITATION FOR BIDS BOOK; THE SPECIAL PROVISIONS INCLUDED IN THE INVITATION FOR BIDS BOOK; THE ADMINISTRATION'S "BOOK OF STANDARDS FOR HIGHWAYS AND INCIDENTAL STRUCTURES" AND THE LATEST ADOPTED MUTCD.

#### RIGHT OF WAY

RIGHT OF WAY AND EASEMENT LINES SHOWN ON THESE PLANS ARE FOR ASSISTANCE IN INTERPRETING THE PLANS. THEY ARE NOT OFFICIAL. FOR OFFICIAL FEE RIGHT OF WAY AND EASEMENT INFORMATION, SEE APPROPRIATE RIGHT OF WAY PLATS.

THE LOCATION OF UTILITIES SHOWN ON THE PLANS ARE FOR INFORMATION AND GUIDANCE ONLY. NO GUARANTEE IS MADE OF THE ACCURACY OF SAID

#### ADA COMPLIANCE

THE DESIGN OF THIS PROJECT HAS INCORPORATED FACILITIES TO ACCOMMODATE PERSONS WITH DISABILITIES IN COMPLIANCE WITH STATE AND FEDERAL REQUIREMENTS.

#### **ENVIRONMENTAL INFORMATION**

GEOMETRIC DESIGN CRITERIA

ALL STORMWATER MANAGEMENT FACILITIES CONSTRUCTED FOR THIS CONTRACT SHALL BE INSPECTED AND MAINTAINED IN ACCORDANCE WITH THE MDOT SHA BEST MANAGEMENT PRACTICES (BMP) INSPECTION AND REMEDIATION PROGRAM.

#### STANDARD STABILIZATION NOTE:

FOLLOWING INITIAL SOIL DISTURBANCE OR REDISTURBANCE, PERMANENT OR TEMPORARY STABILIZATION SHALL BE COMPLETED WITHIN THREE (3) CALENDAR DAYS AS TO THE SURFACE OF ALL PERIMETER CONTROLS, DIKES, SWALES, DITCHES, PERIMETER SLOPES, AND ALL SLOPES GREATER THAN 3 HORIZONTAL TO 1 VERTICAL (3:1), AND SEVEN DAYS (7) AS TO ALL OTHER DISTURBED OR GRADED AREAS ON THE PROJECT SITE.

#### OWNERS / DEVELOPERS CERTIFICATION:

I/WE HEREBY CERTIFY THAT ANY CLEARING, GRADING, CONSTRUCTION AND /OR DEVELOPMENT WILL BE DONE PURSUANT TO THIS PLAN, AND THAT ANY RESPONSIBLE PERSONNEL INVOLVED IN THE CONSTRUCTION PROJECT WILL HAVE A CERTIFICATE OF ATTENDANCE AT A MARYLAND DEPARTMENT OF THE ENVIRONMENT (MDE) APPROVED TRAINING PROGRAM FOR THE CONTROL OF SEDIMENT AND EROSION BEFORE BEGINNING THE PROJECT. I HEREBY AUTHORIZE THE RIGHT OF ENTRY FOR PERIODIC ON-SITE EVALUATION BY MDE COMPLIANCE INSPECTORS

#### **EXISTING STRUCTURES PLANS**

FOR THE CONVENIENCE AND INFORMATION OF BIDDERS, PRINTS OF PLANS OF EXISTING PERTINENT STRUCTURE(S) ARE INCLUDED WITH THIS CONTRACT. NO RESPONSIBILITY FOR THEIR ACCURACY OR COMPLETENESS IS ASSUMED BY THE MDOT SHA. DIMENSIONS, DETAILS, ETC., AS SHOWN THEREON MAY NOT BE AS BUILT.

STORMWATER AND SEDIMENT CONTROL FINAL APPROVAL

APPROVED DATE	-
DIVISION CHIEF, PLAN REVIEW DIVISION	
PRD NO: 17-PR-0056-04 EXPIRATION DATE:	-
APPROVED	DATE
DIVISION CHIEF, INNOVATIVE CONTRACTING DIVISION	
APPROVED	DATE
DIRECTOR, OFFICE OF HIGHWAY DEVELOPMENT	
APPROVED	DATE
DEPUTY ADMINISTRATOR/CHIEF ENGINEER FOR PLANNING, ENGINEERING, REAL ESTATE AND ENVIRONMENT	

**REVISIONS** NOTE: SEE SHEET NO. 2 FOR LIST OF REVISED SHEET NUMBERS

**MODIFICATIONS** 

SHEET NO.	DWG. NO.	
1	_	TITLE SHEET
2	GI-01	INDEX OF SHEETS AND GENERAL NOTES
3–4	DE-01 TO DE-02	DETAIL SHEETS
5–11	SD-01 TO SD-07	SIDEWALK DETAIL SHEETS
12–25	PS-01 TO PS-14	ROADWAY PLAN SHEETS
26	ES-01	EROSIONS AND SEDIMENT CONTROL NOTES

INDEX OF SHEETS

#### MAINTENACE OF TRAFFIC NOTES:

- 1. ALL WORK SHALL BE PERFORMED IN ACCORDANCE WITH THE SHA STANDARD NUMBERS MD 104.00-01 THRU 106.03.
- 2. NO WORK IS TO BEGIN UNTIL TEMPORARY TRAFFIC CONTROL DEVICES INCLUDING, BUT NOT LIMITED TO, ADVANCED WARNING SIGNS, DRUMS, ARROW PANELS, ETC., ARE IN PLACE AND OPERATIONAL.
- 3. ADVANCED NOTIFICATION OF SIDEWALK CLOSURES SHALL BE PROVIDED. A BARRIER THAT IS DETECTABLE BY A PERSON WITH A VISUAL DISABILITY SHALL BE PLACED ACROSS THE FULL WIDTH OF THE SIDEWALK.
- 4. WHERE PEDESTRAINS ARE DIRECTED TO CROSS TO THE OPPOSITE SIDE OF THE ROADWAY, APPROPRIATE ADVANCED SIGNING SHOULD BE PLACED AT THE INTERSECTIONS RATHER THAN MID-BLOCK CROSSINGS.
- 5. TRAFFIC CONTROL DEVICES AND OTHER CONSTRUCTION MATERIALS AND FEATURES SHALL NOT INTRUDE INTO THE USABLE WIDTH OF THE SIDEWALK, TEMPORARY PATHWAY OR OTHER PEDESTRAIN FACILITY.
- 6. PROVIDE ACCESS TO ALL ENTRANCES AND COORDINATE DRIVEWAY ACCESS WITH ADJACENT PROPERTY OWNERS.

#### **GENERAL NOTES**

- 1. BASELINE SHOWN FOR ILLUSTRATIVE PURPOSES
- 2. DIMENSIONS AND STATIONS ARE APPROXIMATE
- 3. ALL SIDEWALK AND RAMPS SHALL BE 60" WIDE, TAPER SIDEWALK TO EXISTING IN ACCORDANCE TO STD. NO. MD 655.02 UNLESS NOTED OTHERWISE. SIDEWALK CROSS SLOPE SHALL BE 2% WHERE THE SIDEWALK TRANSITIONS TO EXISTING, THE CROSS SLOPE SHALL TRANSITION TO EXISTING OVER 5"
- 4. ALL TRANSITION PANELS SHALL BE TO THE NEAREST SIDEWALK JOINT (5' MIN.)
- 5. THE CONTRACTOR MAY ADJUST THE CROSS SLOPE OF THE SIDEWALK TO MAINTAIN THE POSITIVE SHEET FLOW USING A 2% MAXIMUM SIDEWALK SLOPE
- 6. MATCH EXISTING ELEVATIONS AT THE EDGE OF PROPOSED SIDEWALK, SIDEWALK RAMPS AND CURB AND GUTTER. MAXIMUM VERTICAL ELEVATION BETWEEN ADJUCENT SURFACES NOT TO EXCEED 1/4"
- 7. SIDEWALK RECONSTRUCTION LIMITS SHALL COINCIDE WITH CRACK CONTROL JOINTS (JOINTER GROOVES) OR EXPANSION JOINTS IN EXISTING SIDEWALK. NEW EXPANSION JOINTS SHALL BE PROVIDED AT THE INTERFACE OF EXISTING AND PROPOSED SIDEWALK. SEE SHA STANDARD MD-655.01.
- 8. FORM NEW SIDEWALK AND EXPANSION JOINT MATERIAL AROUND EXISTING UTILITY POLES MANHOLE COVERS, VALVE COVERS AND FIRE HYDRANTS AS NECESSARY.
- 9. INSTALL DETECTABLE WARNING SURFACE ON SIDEWALK RAMPS AS PER SHA STANDARD MD-655.40.
- 10. ALL DRIVEWAY ENTRANCES THAT HAVE CURB RETURNS MUST CARRY A MINIMUM 36" WIDE PEDESTRAIN PATHWAY WITH A MAXIMUM 2% CROSS-SLOPE ACROSS THE ENTRANCE REGARDLESS OF WHAT MATERIAL IS USED TO CONSTRUCT THE ENTRANCE.
- 11. ALL DISTURBED AREAS BEYOND 2' FROM THE EDGE OF SIDEWALK /RAMP SHALL RECIEVE 4" TOPSOIL AND SOD.
- 12. RESET ANY SIGNS DISTURBED BY THE CONSTRUCTION AS DIRECTED BY THE ENGINEER
- 13. ADJUST EXISTING UTILITIES AS REQUIRED FOR SIDEWALK AND RAMP REPLACEMENT.
- 14. THE COONTRACTOR SHALL REPLACE EXISTING DAMAGED CURB WHICH IS ADJACENT TO LOCATIONS WHERE CURB RAMPS ARE BEING RECONSTRUCTED OR INSTALLED.
- 15. EXISTING CURB HEIGHTS PROVIDED ON THE PLANS SHALL BE VERIFIED BY THE CONTRACTOR. RAMP AND DRIVEWAY TRANSTION LENGTHS SHALL BE VERIFIED IN THE FIELD ACCORDING TO SHA STANDARDS MD-630.01, MD-630.02, MD-655.11, MD-655.12 AND MD-655.13.
- 16. ALL CURB REPLACEMENTS TERMINI ADJACENT TO PARKING LOT DRIVEWAY ENTRANCES SHALL BE CONSTRUCTED NOSE DOWN TO MATCH EXISTING GRADE OR AS DIRECTED BY THE ENGINEER.
- 17. EXISTING INLETS SHALL NOT BE DAMAGED DURING CONSTRUCTION, CONTRACTOR SHALL REPLACE INLETS DAMAGED BY HIS ACTIVITES AT NO ADDITIONAL COST TO THE ADMINISTRATION.
- 18. EXISTING TREES, SHRUBS AND THEIR RESPECTIVE ROOT SYSTEMS SHALL NOT BE DISTURBED DURING CONSTRUCTION UNLESS OTHERWISE NOTED.
- 19. PAVEMENT MARKINGS SHOWN ARE EXISTING UNLESS OTHERWISE NOTED.
- 20. NO DISTURBED AREA SHALL BE LEFT UNSTABILIZED OVERNIGHT
- 21. SEDIMENT AND EROSION CONTROL REGULATIONS WILL BE STRICTLY ENFORCED DURING CONSTRUCTION



INNOVATIVE CONTRACTING DIVISION

REPACEMENT AND REPAIR OF SIDEWALKS IN DISTRICT 2 AREA WIDE

STATE HIGHWAY
ADMINISTRATION

MD 33 (TALBOT STREET) 200' NORTH

OF LEE STREET TO

150' SOUTH OF SPENCER DRIVE

R /W PLAT NUMBER	REVISIONS	INDEX OF	SHEETS AND	GENERAL NOTES
		SCALE N.T.S.	DATE MARCH 2020	CONTRACT NO. TA2295133
		DESIGNED BYAUO DRAWN BY PNK	COUN'	


 DESIGNED BY
 AUO
 COUNTY
 TALBOT COUNTY


 DRAWN BY
 PNK
 LOGMILE
 12.852 TO 13.983


 CHECKED BY
 RJM
 HORIZONTAL SCALE
 N/A

 MDE/PRD
 17-PR-0056-04
 VERTICAL SCALE
 N/A


 DRAWING NO.
 GI-01
 OF GI-01
 SHEET NO.
 2 OF 26

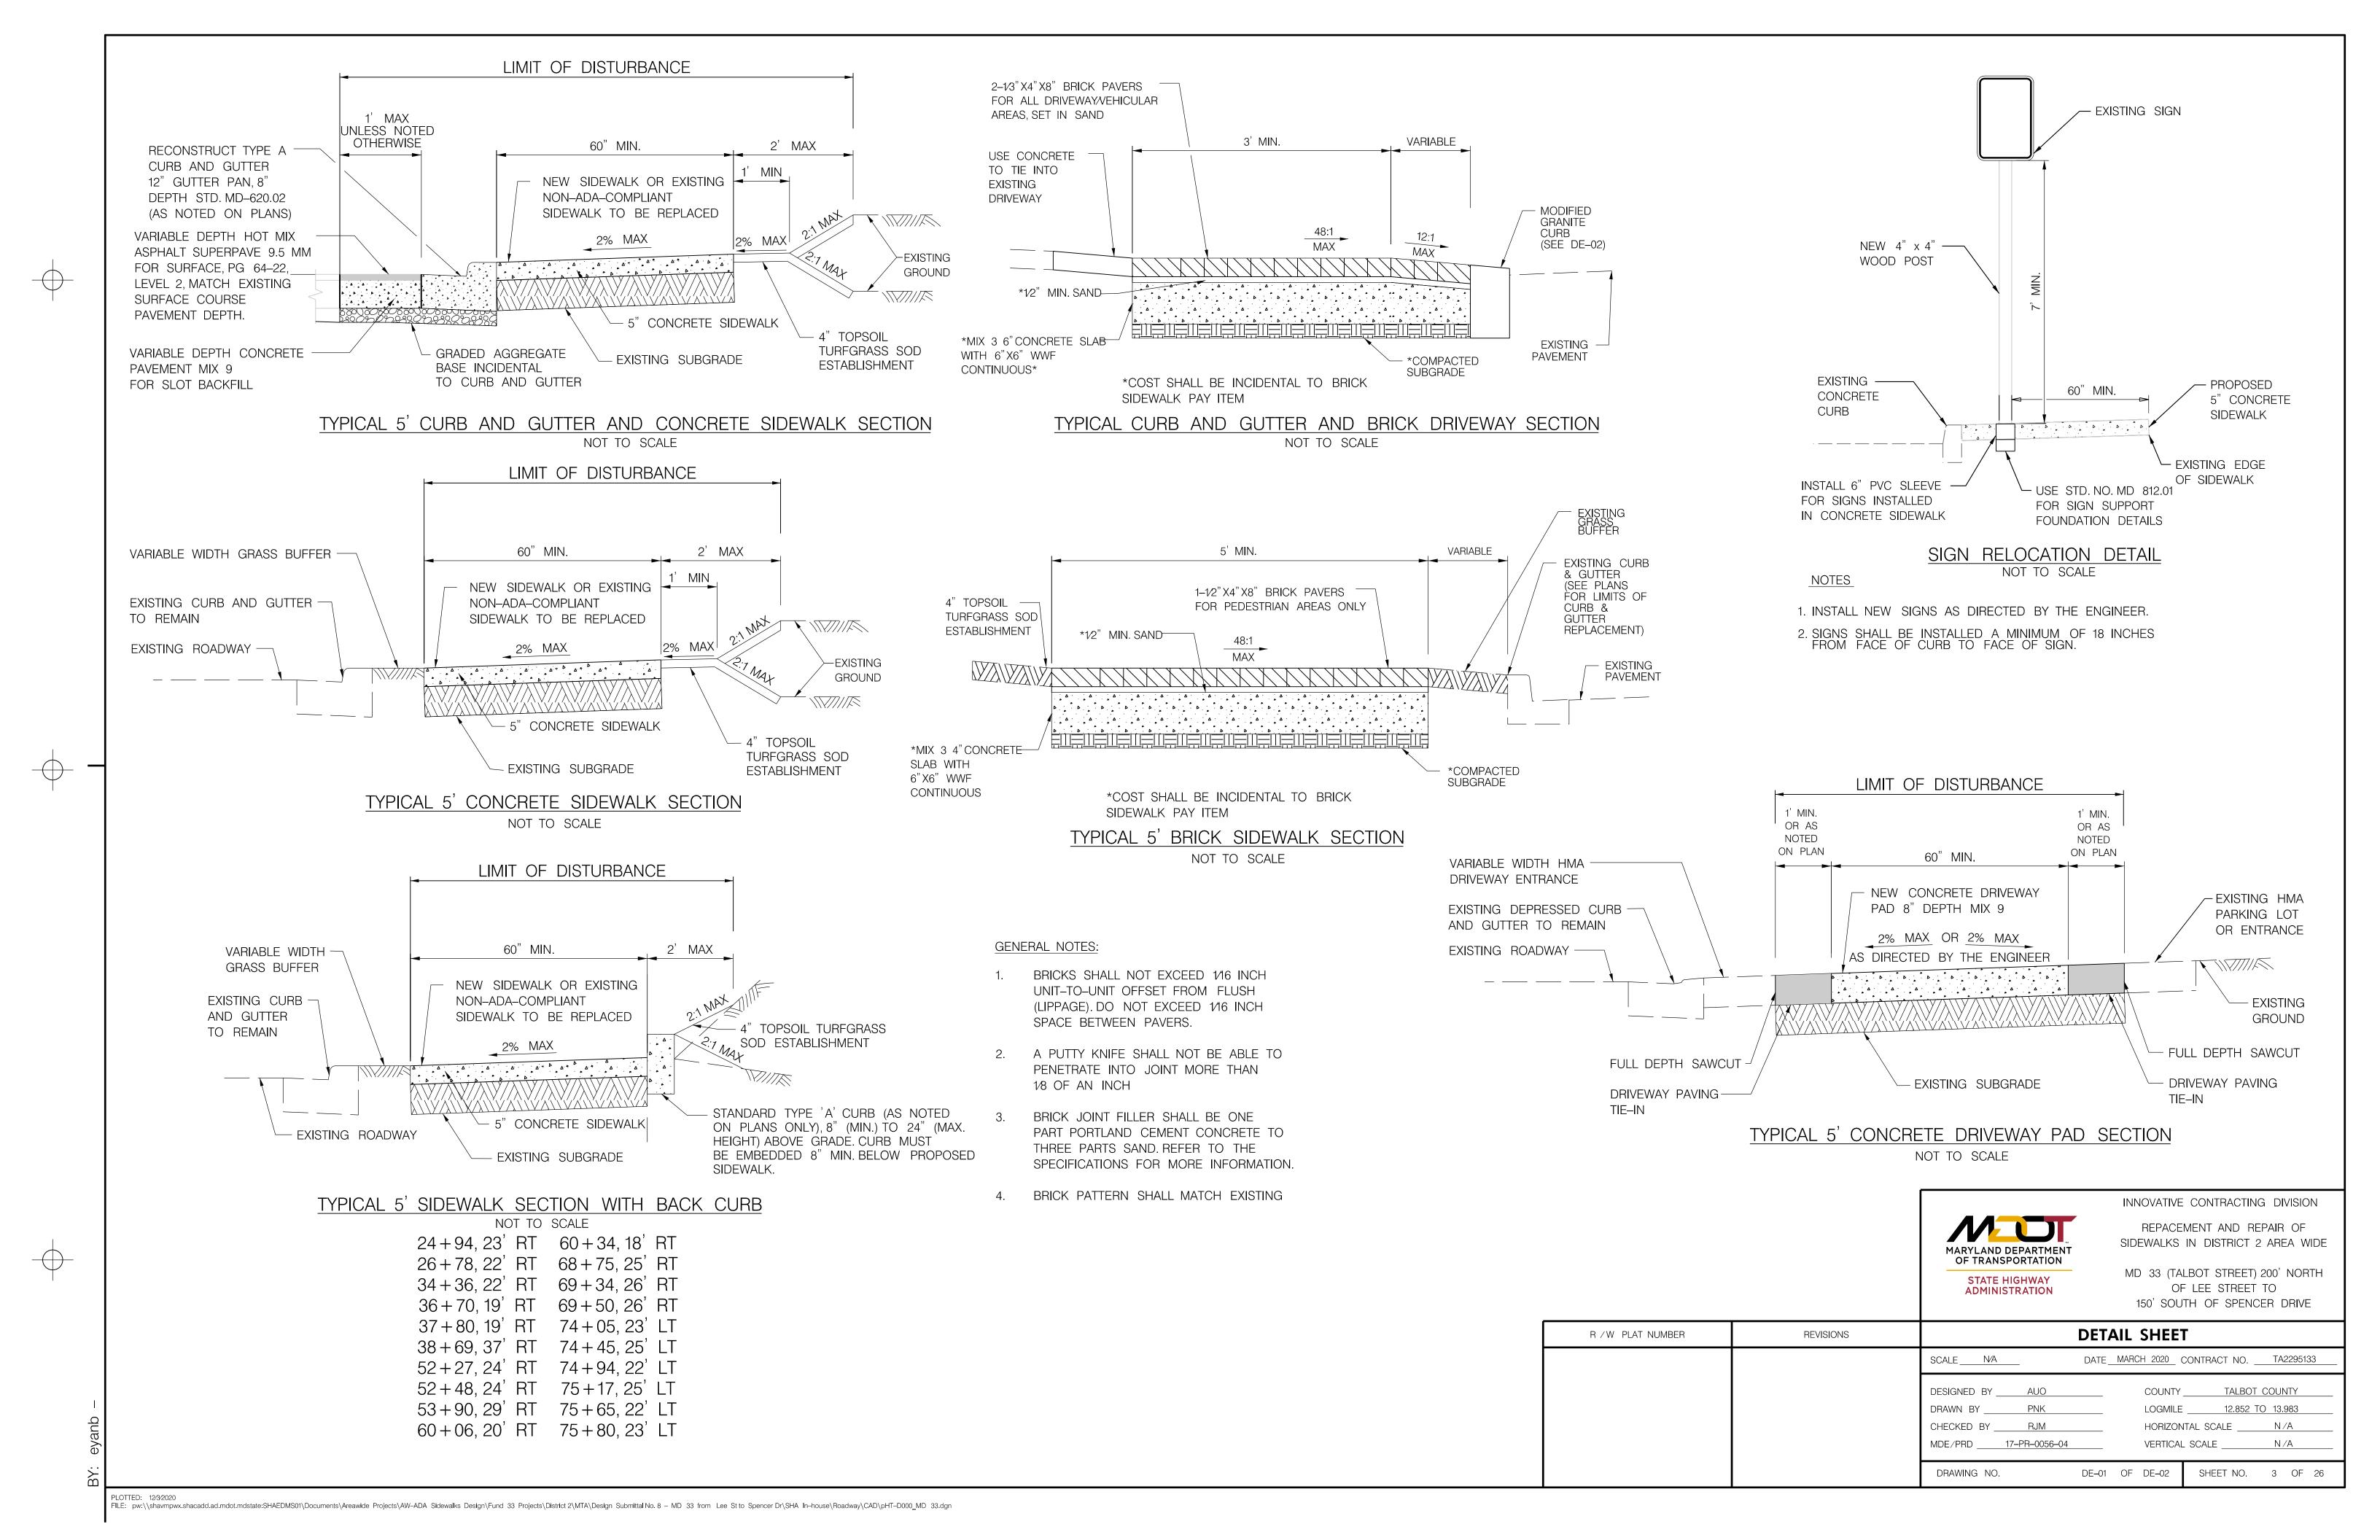

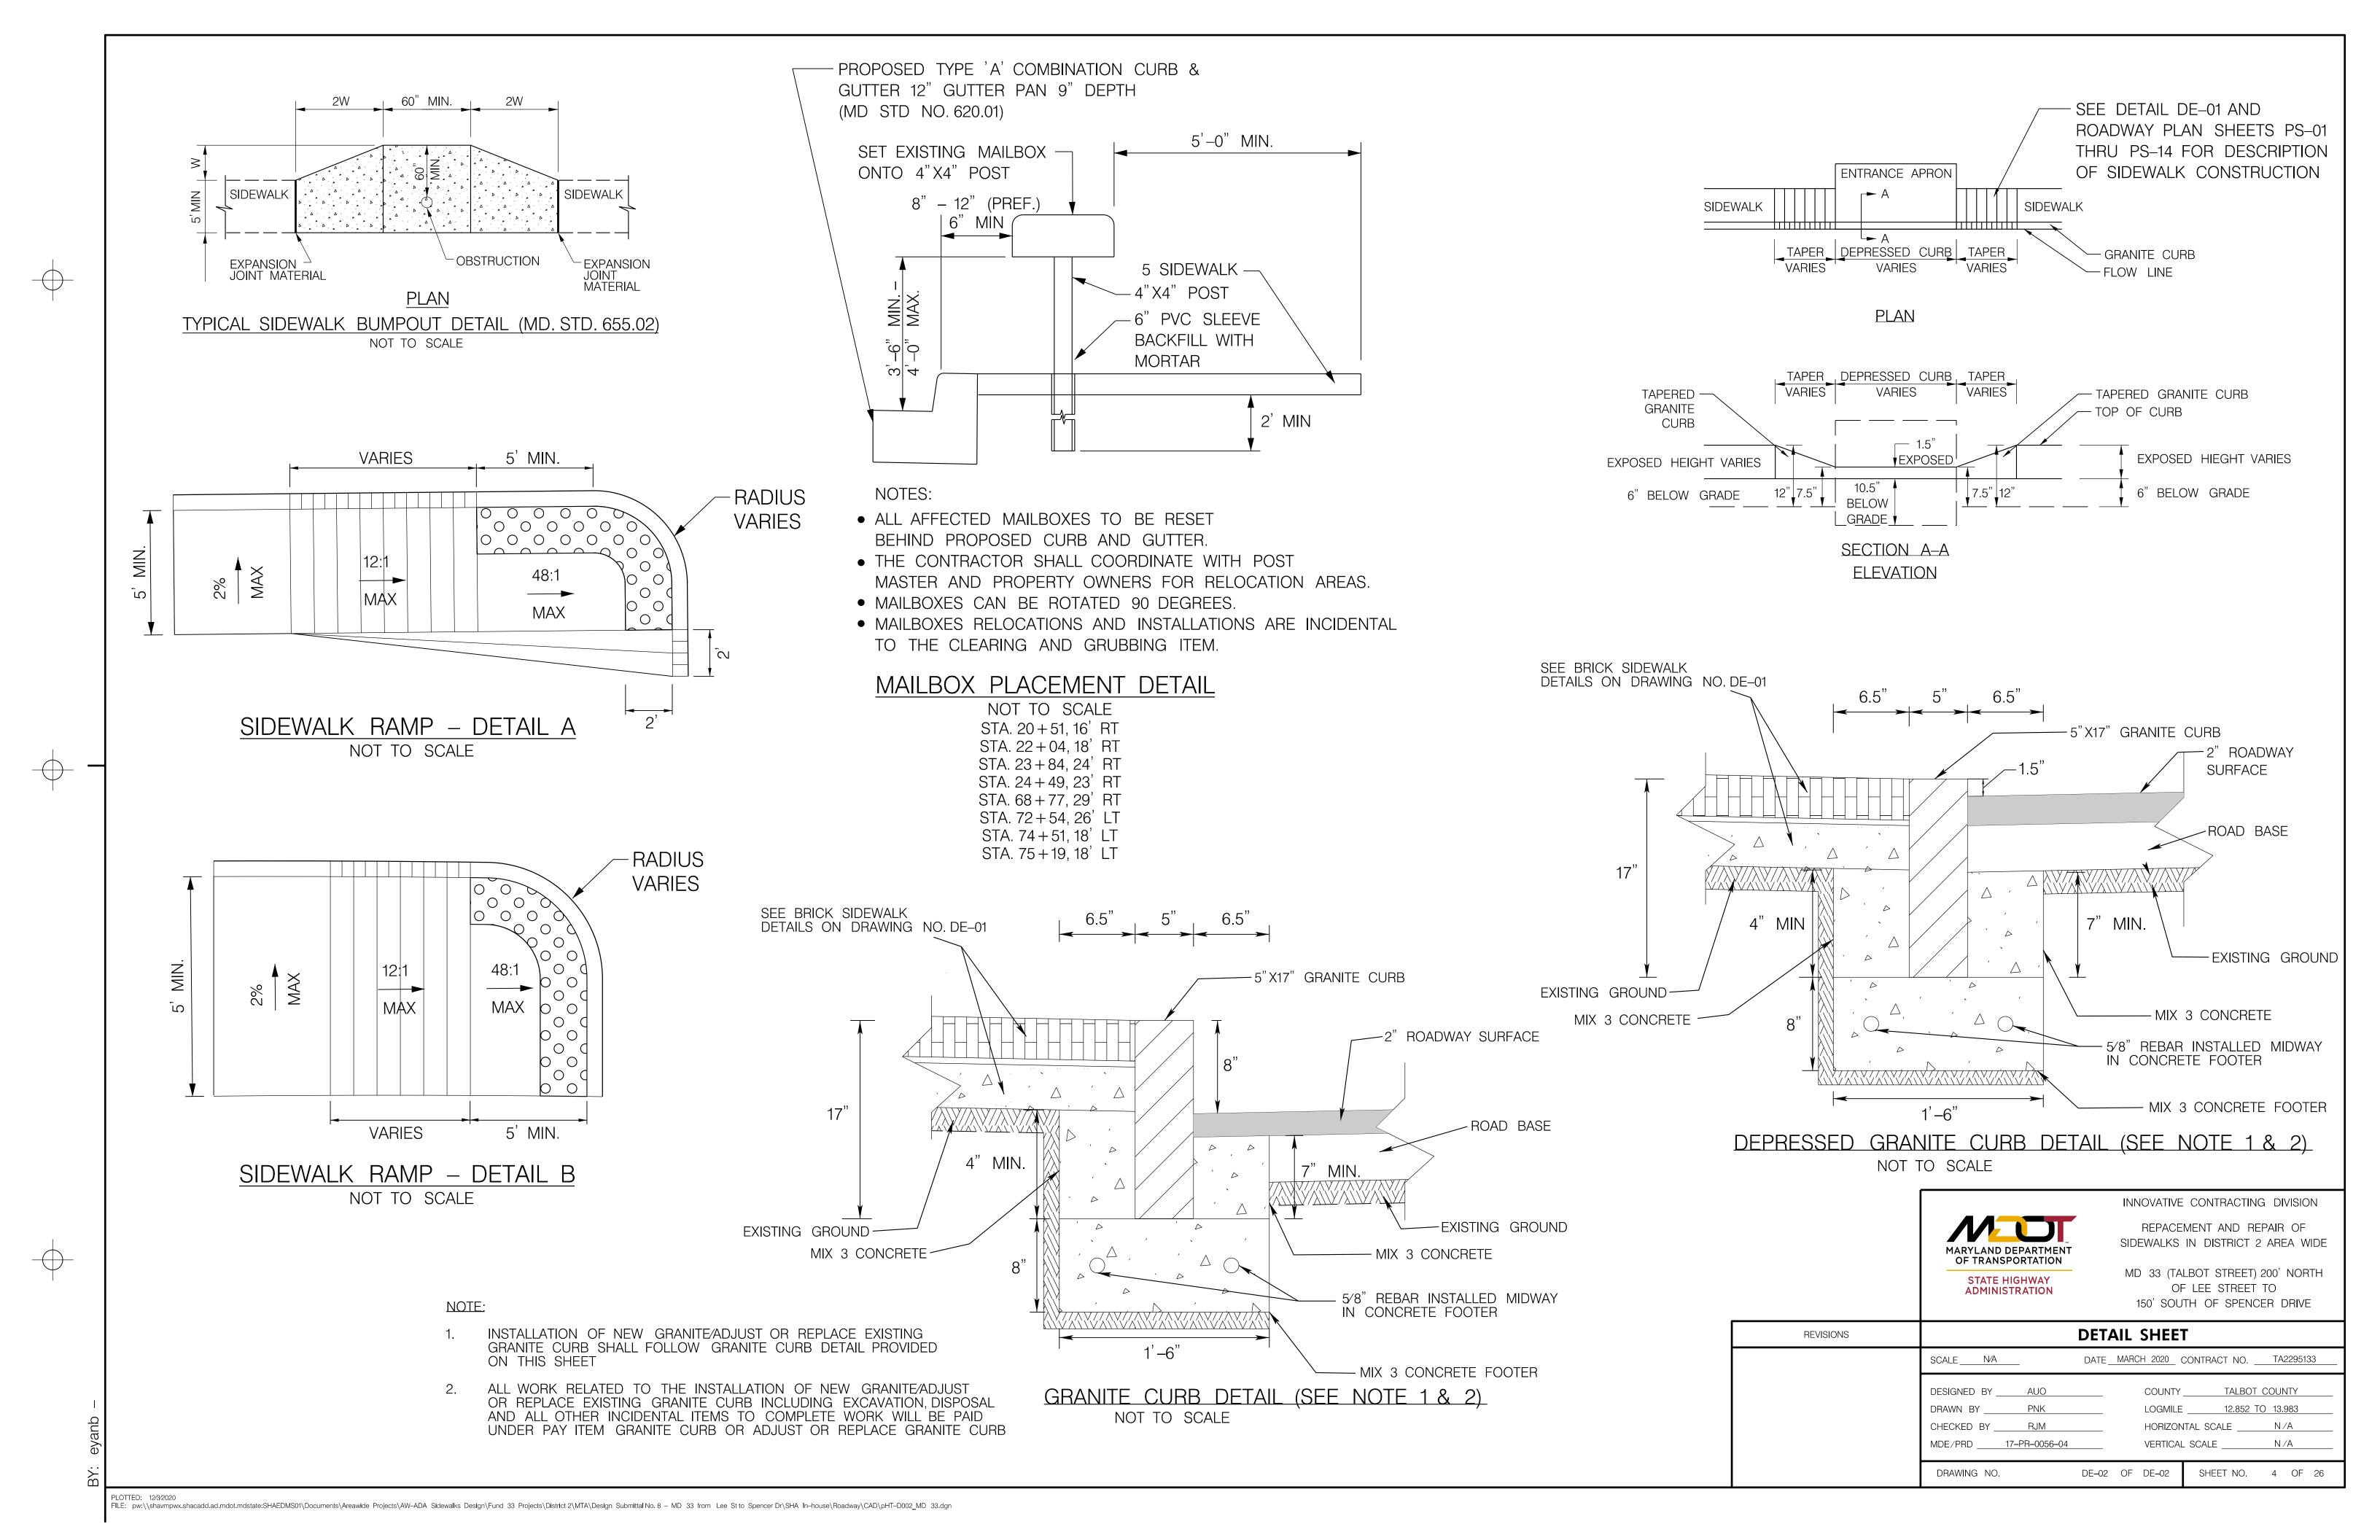


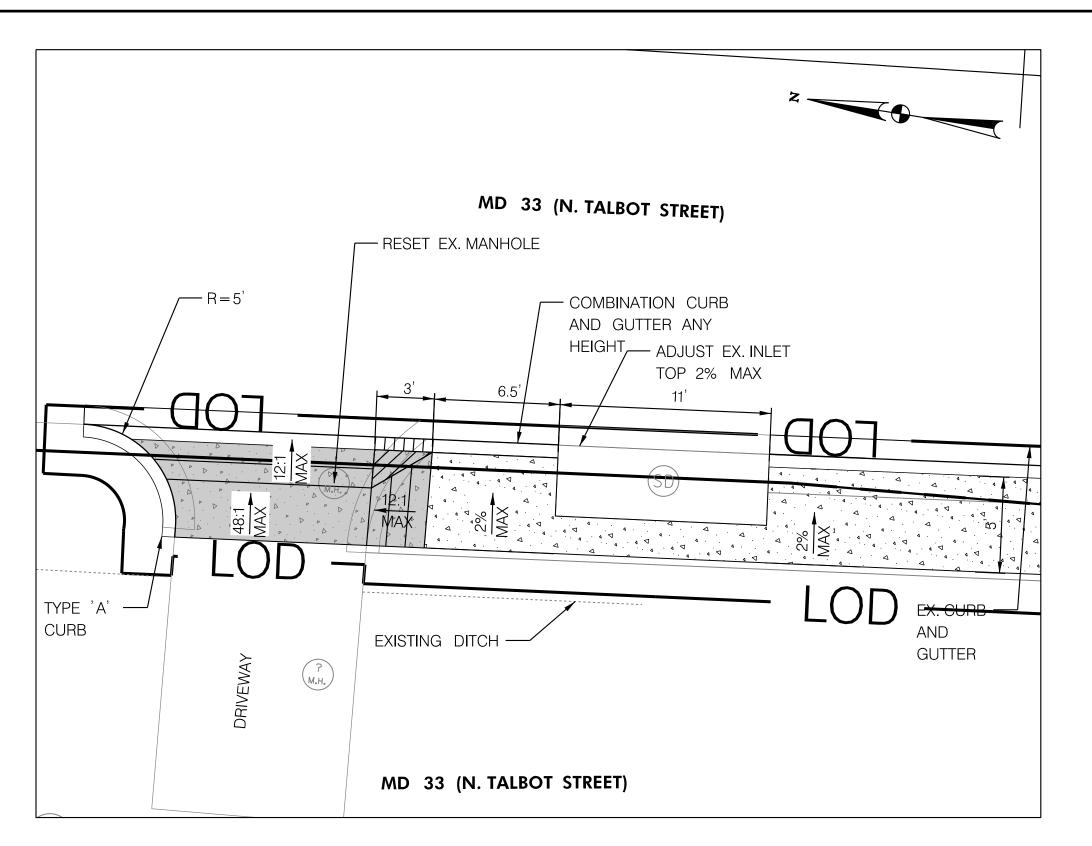


STA 18+70 RT. SIDEWALK RAMP DETAIL NOT TO SCALE

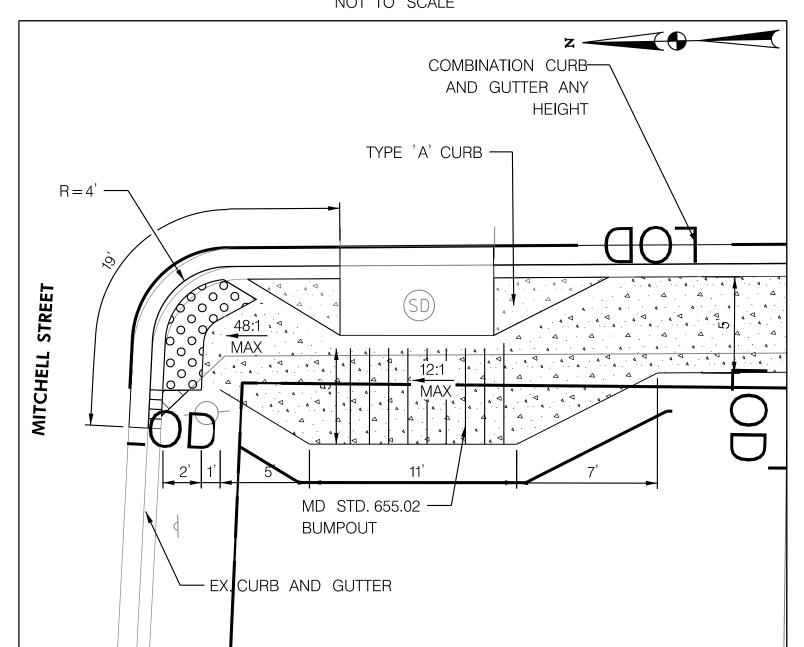


STA 24+94 RT. SIDEWALK RAMP DETAIL NOT TO SCALE

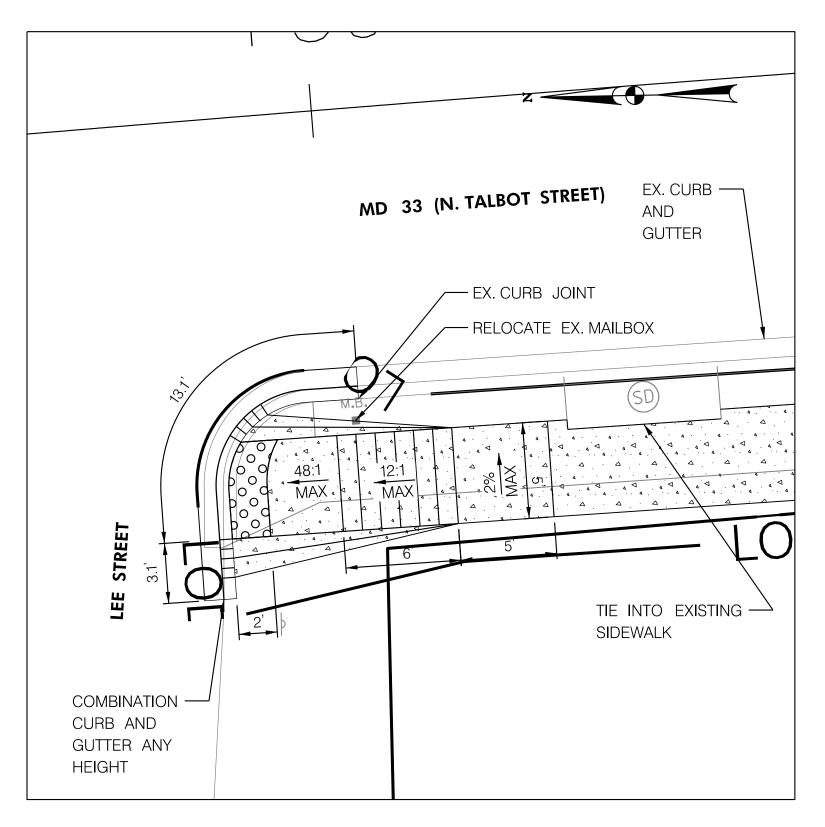


STA 20+47 RT. SIDEWALK RAMP DETAIL NOT TO SCALE

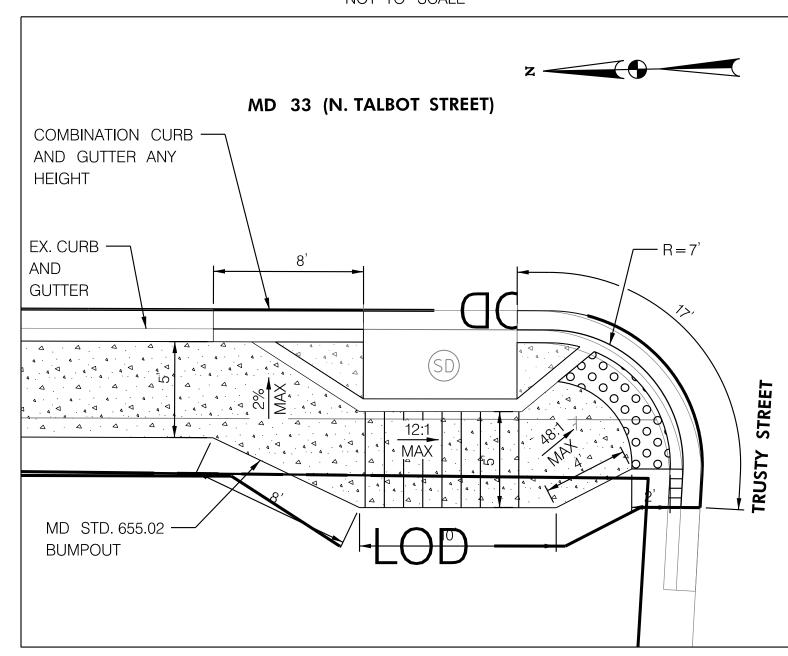

STA 26+56 RT. SIDEWALK RAMP DETAIL NOT TO SCALE

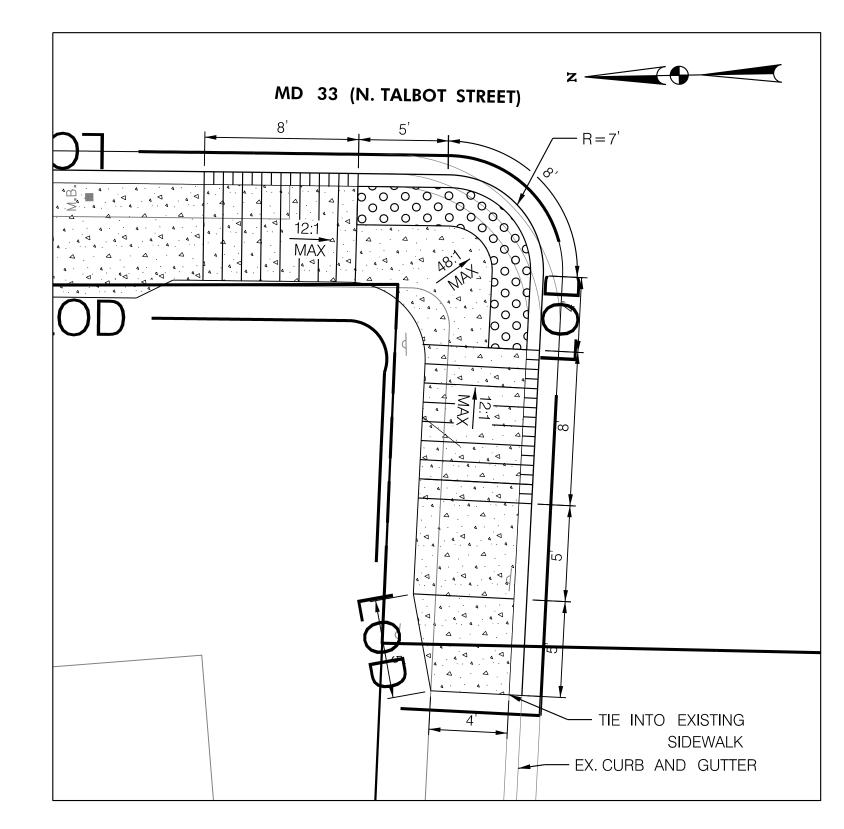

STA 24+63 RT. SIDEWALK RAMP DETAIL NOT TO SCALE

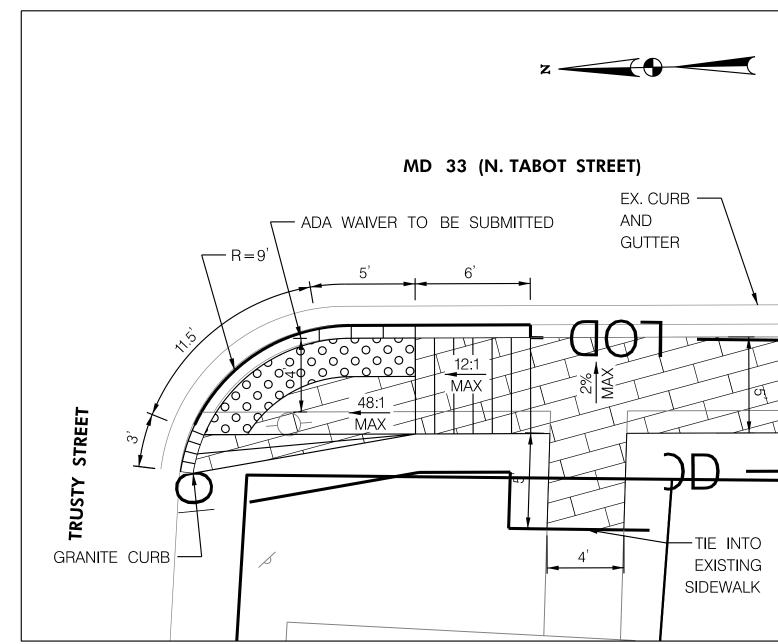

STA 26+92 RT. SIDEWALK RAMP DETAIL NOT TO SCALE

MARYLAND DEPARTMENT OF TRANSPORTATION STATE HIGHWAY **ADMINISTRATION** 

INNOVATIVE CONTRACTING DIVISION

REPACEMENT AND REPAIR OF SIDEWALKS IN DISTRICT 2 AREA WIDE

MD 33 (TALBOT STREET) 200' NORTH OF LEE STREET TO


150' SOUTH OF SPENCER DRIVE

#### NOTE TO CONTRACTOR:


- 1. ALL DISTURBED AREAS SHALL BE TEMPORARILY STABILIZED AT THE END OF EACH WORK DAY WITH TYPE 'E' SOIL STABILIZATION MATTING IN PERVIOUS AREAS OR GRADED AGGREGATE BASE COURSE IN IMPERVIOUS AREAS.
- 2. NO DISTURBED AREA SHALL BE LEFT UNSTABLIZED OVERNIGHT UNLESS THE RUNOFF IS DIRECTED TO AN MDE APPROVED SEDIMENT CONTROL DEVICE.
- 3. SEE GENERAL NOTES ON SHEET DE-01 FOR ADDITIONAL CONSTRUCTION NOTES FOR CURB RAMPS, SIDEWALKS, AND MEDIANS.
- 4. ALL TRANSITION SIDEWALK PANELS MUST BE CONSTRUCTED 5' MINIMUM OR TO THE NEXT EXISTING JOINT OR AS DIRECTED BY THE ENGINEER.

SIDEWALK DETAIL SHEET PAVEMENT LEGEND R / W PLAT NUMBER REVISIONS CONCRETE SIDEWALK DATE MARCH 2020 CONTRACT NO. \_\_\_\_TA2295133 SCALE AS SHOWN BRICK SIDEWALK CONCRETE DRIVEWAY ENTRANCE STAMPED CONCRETE DESIGNED BY \_\_\_\_\_ AUO COUNTY \_\_\_ TALBOT COUNTY DRIVEWAY TIE-IN PNK DRAWN BY LOGMILE \_ 12.852 TO 13.983 SIDEWALK REMOVAL CHECKED BY \_\_\_\_\_RJM HORIZONTAL SCALE \_\_\_\_\_N/A SIDEWALK RAMP - LOD - LIMIT OF DISTURBANCE MDE/PRD \_\_\_\_\_17-PR-0056-04 VERTICAL SCALE \_\_\_\_ N/A - CBCA - CHESAPEAKE BAY CRITICAL AREA 0000 DETECTABLE WARNING SHEET NO. 5 OF 26 DRAWING NO. SD-01 OF SD-07

FILE: pw:\\shavmpwx.shacadd.ad.mdot.mdstate:SHAEDMS01\Documents\Areawide Projects\AW-ADA Sidewalks Design\Fund 33 Projects\District 2\MTA\Design Submittal No. 8 - MD 33 from Lee St to Spencer Dr\SHA In-house\Roadway\CAD\pSD-P001\_MD 33.dgn

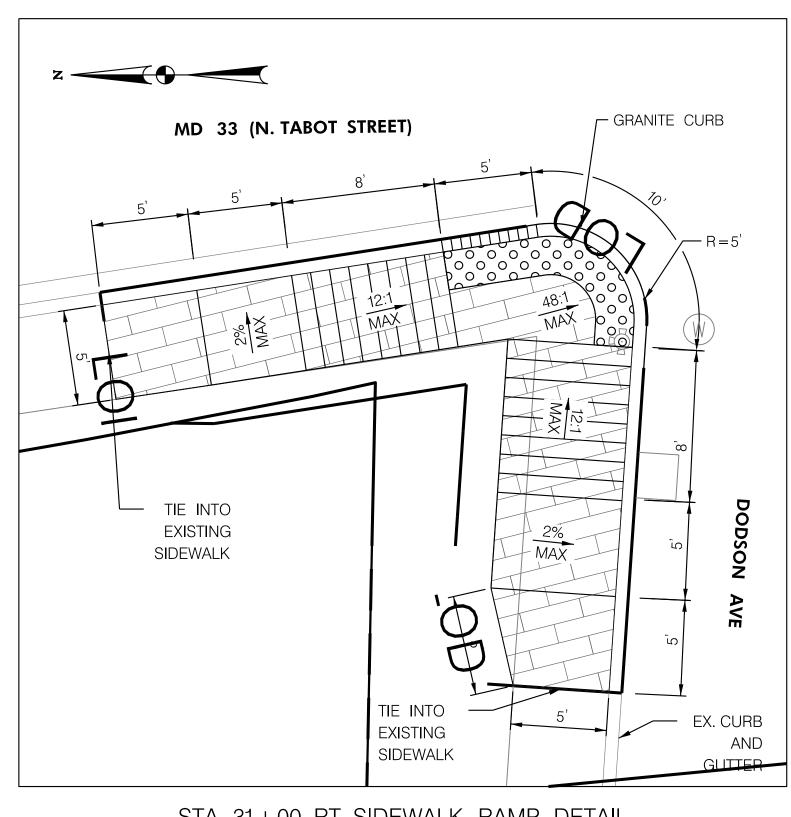

STA 31+00 RT. SIDEWALK RAMP DETAIL NOT TO SCALE

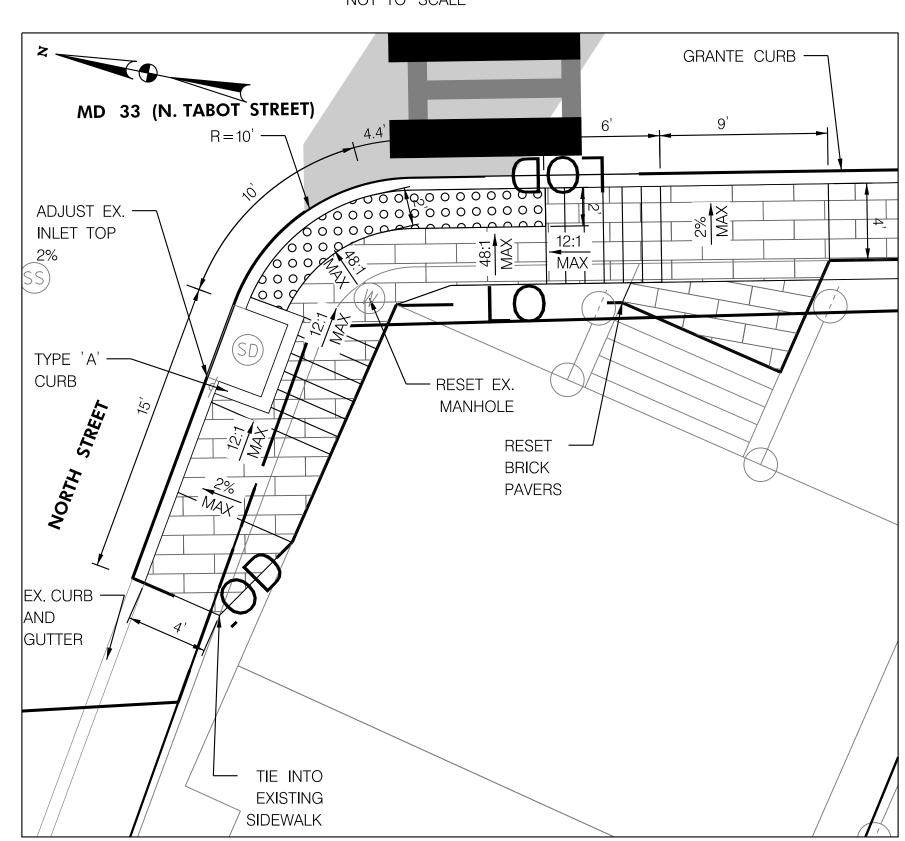

STA 31 + 25 RT. SIDEWALK RAMP DETAIL

EX. GUY

NEEDED

TRIM SHRUB FOR SIDEWALK AS

MD 33 (N. TABOT STREET)

RESET INLET TO

2% CROSS

SLOPE


GRANITE -

CURB


R = 5

EX. CURB -


GUTTER

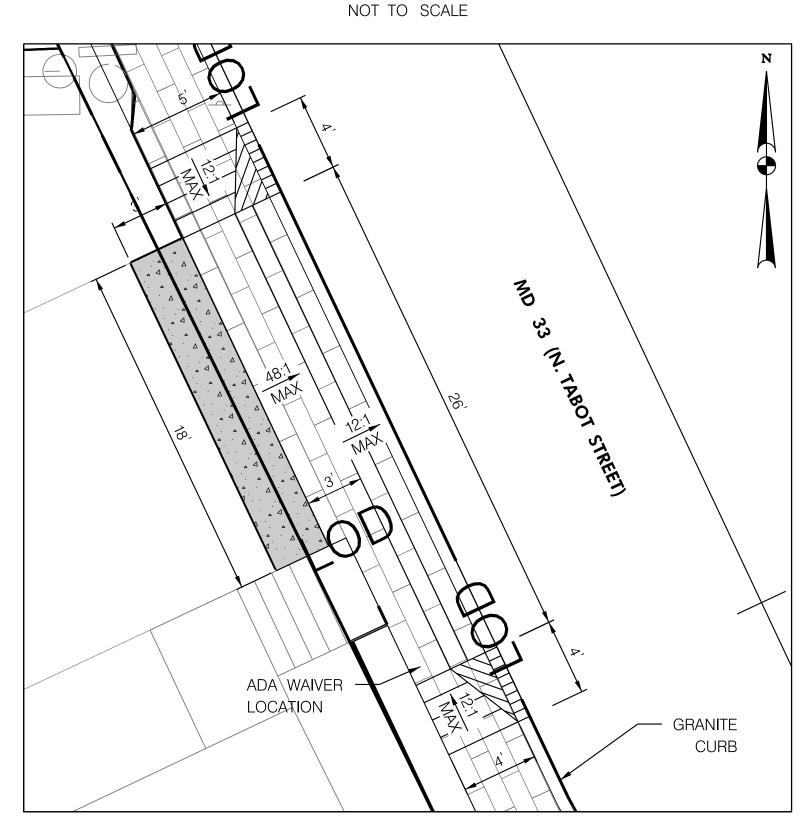

STA 35+25 RT. SIDEWALK RAMP DETAIL (ADA WAIVER LOCATION) NOT TO SCALE

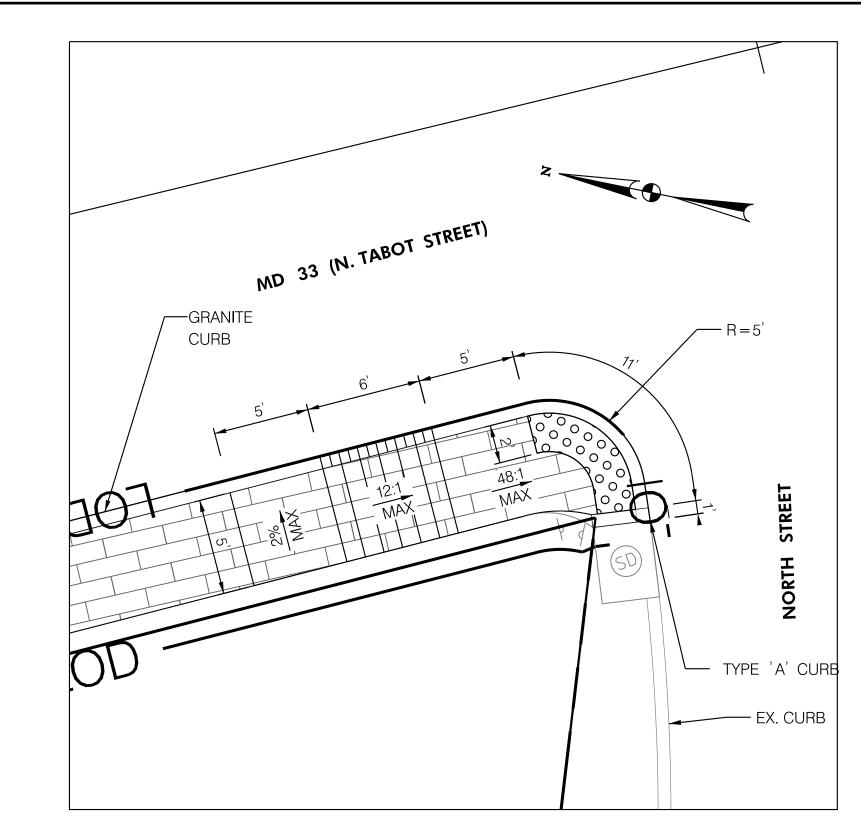

STA 34+10 RT. SIDEWALK RAMP DETAIL NOT TO SCALE

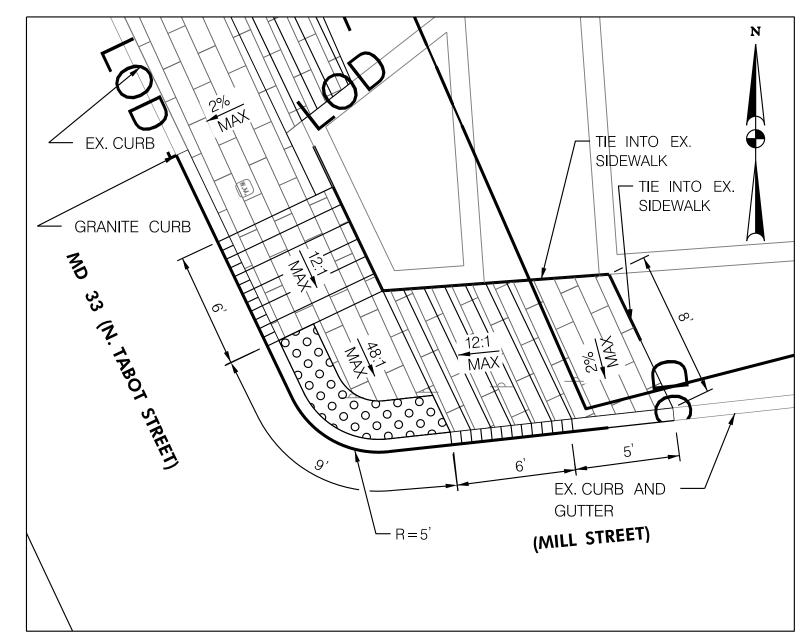

STA 36+23 LT. SIDEWALK RAMP DETAIL NOT TO SCALE

REVISIONS

MARYLAND DEPARTMENT OF TRANSPORTATION STATE HIGHWAY

SCALE AS SHOWN

DRAWN BY

DRAWING NO.

DESIGNED BY \_\_\_\_\_ AUO\_

CHECKED BY \_\_\_\_\_RJM

MDE/PRD \_\_\_\_\_17-PR-0056-04

INNOVATIVE CONTRACTING DIVISION

REPACEMENT AND REPAIR OF SIDEWALKS IN DISTRICT 2 AREA WIDE

MD 33 (TALBOT STREET) 200' NORTH OF LEE STREET TO 150' SOUTH OF SPENCER DRIVE

# **ADMINISTRATION**

SIDEWALK DETAIL SHEET DATE MARCH 2020 CONTRACT NO. \_\_\_\_TA2295133 COUNTY \_\_\_ TALBOT COUNTY LOGMILE \_\_ 12.852 TO 13.983

HORIZONTAL SCALE \_\_\_\_\_N/A

N/A

SHEET NO. 6 OF 26

VERTICAL SCALE \_\_\_\_

SD-02 OF SD-07

1. ALL DISTURBED AREAS SHALL BE TEMPORARILY STABILIZED AT THE END OF EACH WORK DAY WITH TYPE 'E' SOIL STABILIZATION MATTING IN PERVIOUS AREAS. 2. NO DISTURBED AREA SHALL BE LEFT UNSTABLIZED OVERNIGHT UNLESS THE RUNOFF IS DIRECTED TO AN MDE APPROVED SEDIMENT CONTROL DEVICE.

PAVEMENT LEGEND

CONCRETE SIDEWALK

R / W PLAT NUMBER

CONCRETE DRIVEWAY ENTRANCE

DRIVEWAY TIE-IN - LOD - LIMIT OF DISTURBANCE

BRICK SIDEWALK SIDEWALK RAMP


STAMPED CONCRETE SIDEWALK REMOVAL 0000 - CBCA - CHESAPEAKE BAY CRITICAL AREA DETECTABLE WARNING SURFACE

AND MEDIANS. 4. ALL TRANSITION SIDEWALK PANELS MUST BE CONSTRUCTED 5' MINIMUM OR TO THE NEXT EXISTING JOINT OR AS DIRECTED BY THE ENGINEER.


STA 34+57 RT. SIDEWALK RAMP DETAIL

3. SEE GENERAL NOTES ON SHEET DE-01 FOR ADDITIONAL CONSTRUCTION NOTES FOR CURB RAMPS, SIDEWALKS,

NOT TO SCALE NOTE TO CONTRACTOR:

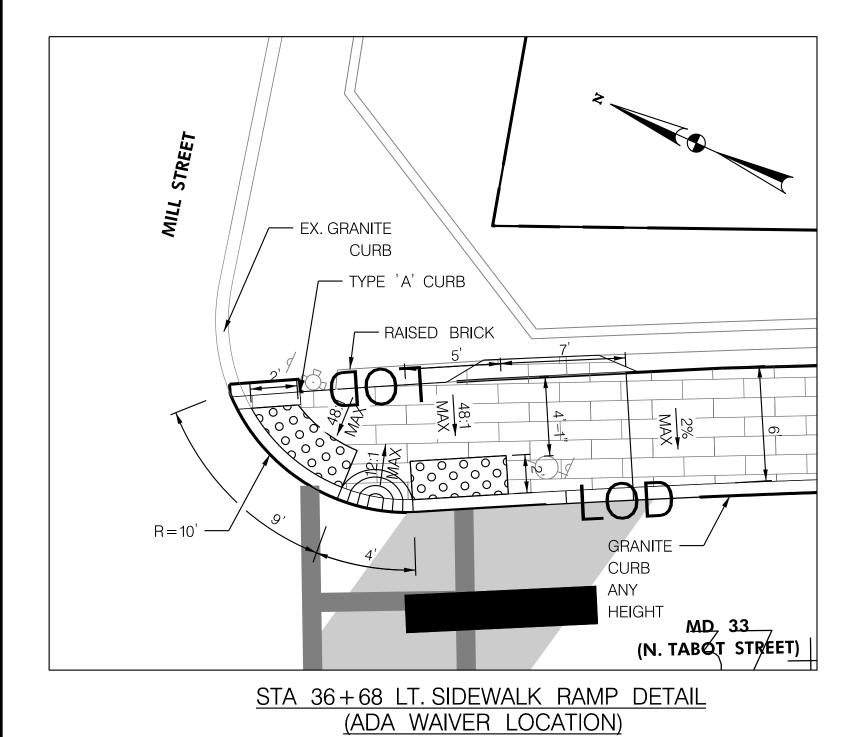

NOT TO SCALE

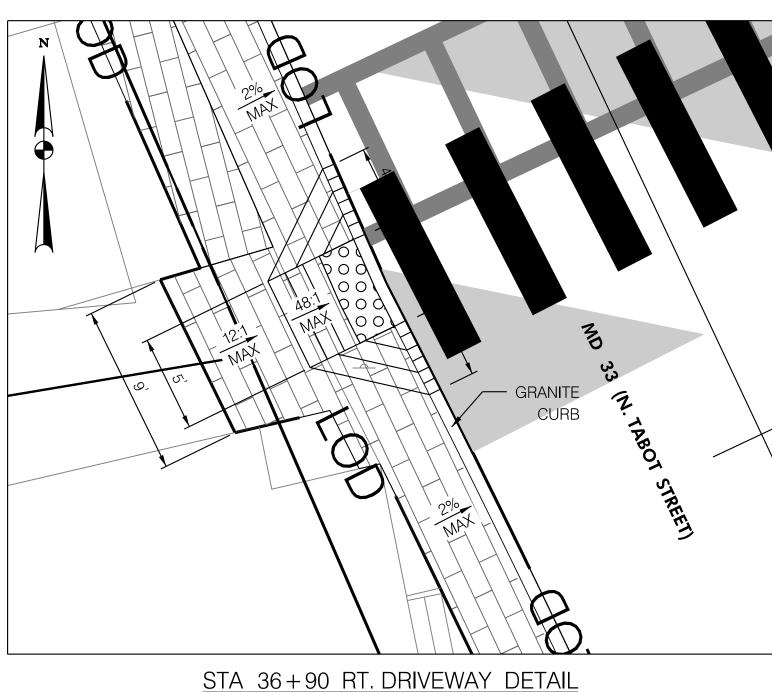

NOT TO SCALE

RESET EX.
MANHOLE

MD 33 (N. TABOT STREET)

GRANITE CURB ANY
HEIGHT

4

4

A

A


BOLLARD

RESET EX.
BOLLARD

TIE INTO
EXISTING
SIDEWALK


STA 37+33 RT. DRIVEWAY RAMP DETAIL

NOT TO SCALE

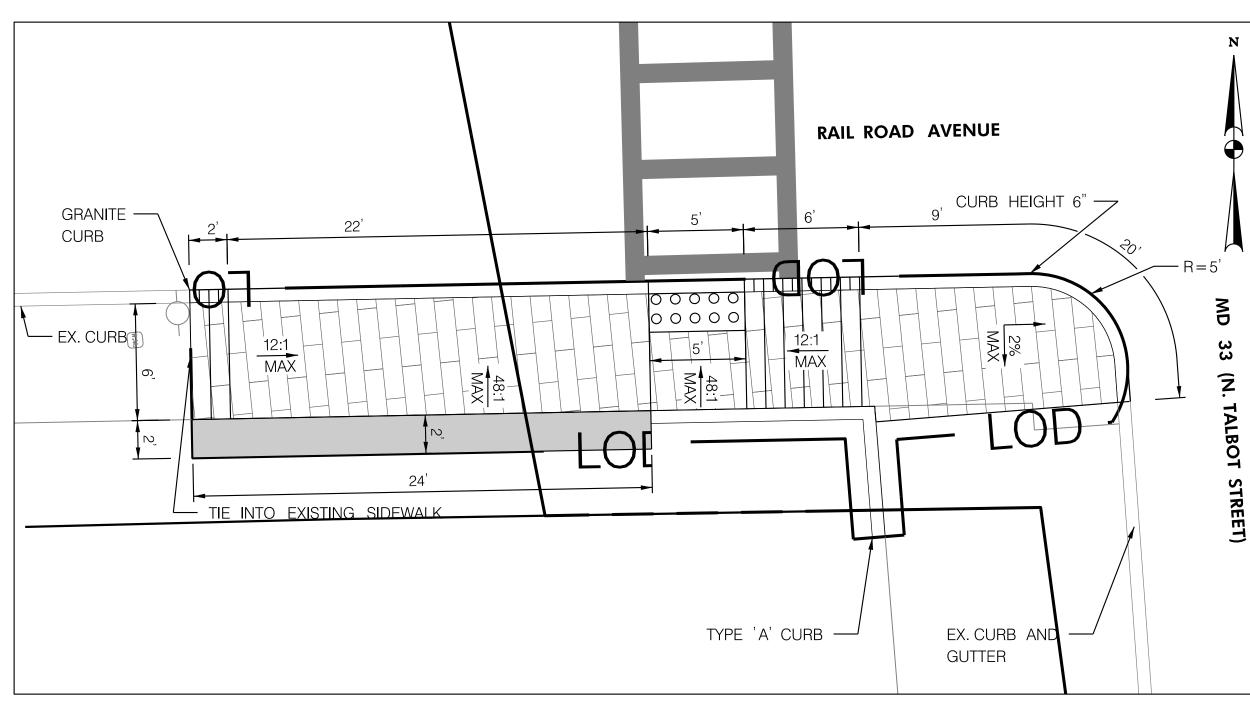


STA 38+56 RT. DRIVEWAY DETAIL

NOT TO SCALE

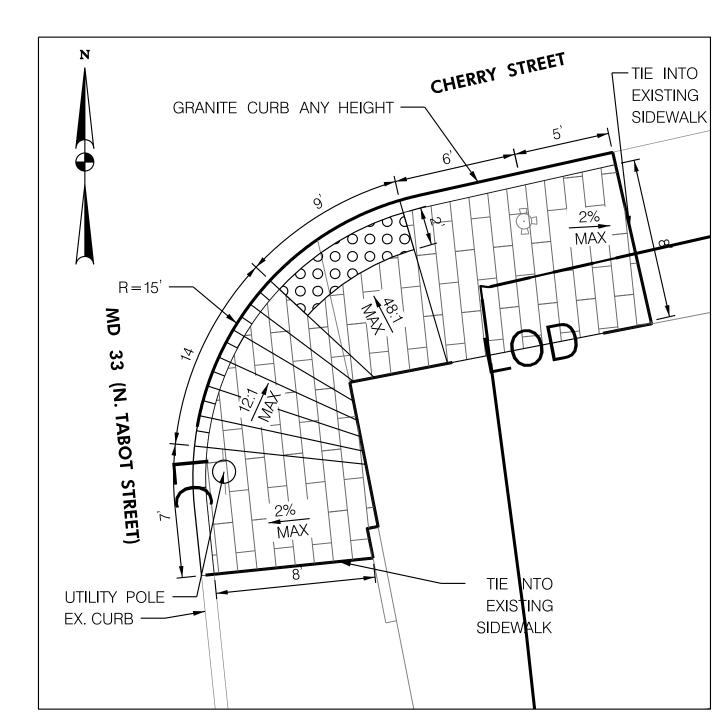

STA 38+77 LT. SIDEWALK RAMP DETAIL NOT TO SCALE

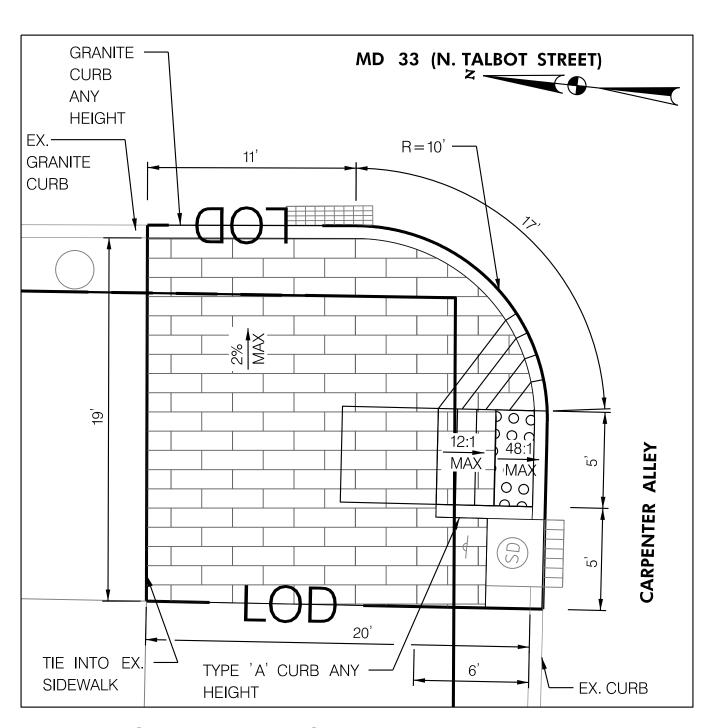

STA 41+38 RT. SIDEWALK RAMP DETAIL

NOT TO SCALE

MARYLAND DEPARTMENT OF TRANSPORTATION

STATE HIGHWAY

**ADMINISTRATION** 

INNOVATIVE CONTRACTING DIVISION

REPACEMENT AND REPAIR OF SIDEWALKS IN DISTRICT 2 AREA WIDE

MD 33 (TALBOT STREET) 200' NORTH

OF LEE STREET TO

150' SOUTH OF SPENCER DRIVE

# NOTE TO CONTRACTOR:


- 1. ALL DISTURBED AREAS SHALL BE TEMPORARILY STABILIZED AT THE END OF EACH WORK DAY WITH TYPE 'E' SOIL STABILIZATION MATTING IN PERVIOUS AREAS OR GRADED AGGREGATE BASE COURSE IN IMPERVIOUS AREAS.
- 2. NO DISTURBED AREA SHALL BE LEFT UNSTABLIZED OVERNIGHT UNLESS THE RUNOFF IS DIRECTED TO AN MDE APPROVED SEDIMENT CONTROL DEVICE.
- 3. SEE GENERAL NOTES ON SHEET DE-01 FOR ADDITIONAL CONSTRUCTION NOTES FOR CURB RAMPS, SIDEWALKS, AND MEDIANS.
- 4. ALL TRANSITION SIDEWALK PANELS MUST BE CONSTRUCTED 5' MINIMUM OR TO THE NEXT EXISTING JOINT OR AS DIRECTED BY THE ENGINEER.


SIDEWALK DETAIL SHEET PAVEMENT LEGEND R / W PLAT NUMBER REVISIONS CONCRETE SIDEWALK DATE MARCH 2020 CONTRACT NO. \_\_\_\_TA2295133 SCALE AS SHOWN BRICK SIDEWALK CONCRETE DRIVEWAY ENTRANCE STAMPED CONCRETE DESIGNED BY \_\_\_\_\_ AUO COUNTY \_\_\_ TALBOT COUNTY DRIVEWAY TIE-IN PNK LOGMILE \_\_ 12.852 TO 13.983 SIDEWALK REMOVAL CHECKED BY \_\_\_\_\_RJM HORIZONTAL SCALE \_\_\_\_\_N/A SIDEWALK RAMP - LOD - LIMIT OF DISTURBANCE MDE/PRD \_\_\_\_\_\_17-PR-0056-04 VERTICAL SCALE \_\_\_\_ N/A 0000 - CBCA - CHESAPEAKE BAY CRITICAL AREA DETECTABLE WARNING SURFACE SHEET NO. 7 OF 26 DRAWING NO. SD-03 OF SD-07


PLOTTED: 12/3/2020
FILE: pw:\\shavmpwx.shacadd.ad.mdot.mdstate:SHAEDMS01\Documents\Areawide Projects\AW-ADA Sidewalks Design\Fund 33 Projects\District 2\MTA\Design Submittal No. 8 - MD 33 from Lee St to Spencer Dr\SHA In-house\Roadway\CAD\pSD-P003\_MD 33.dgn




\_

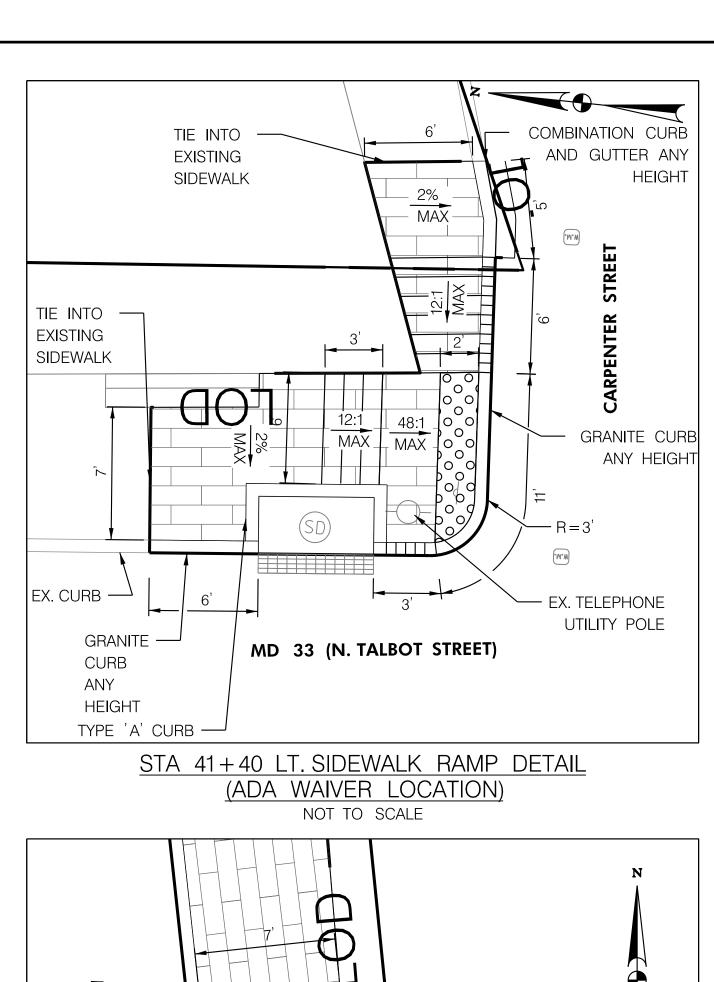

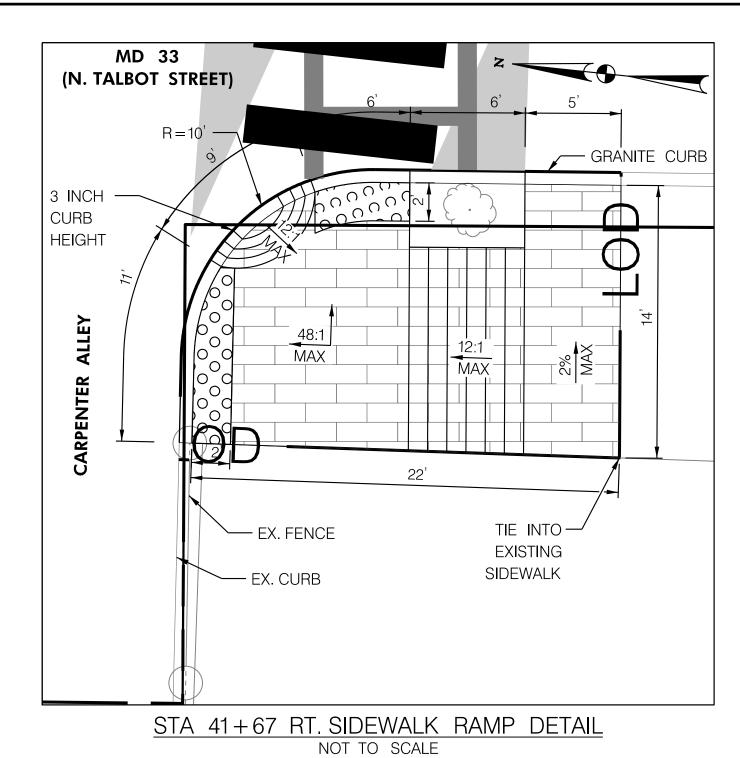

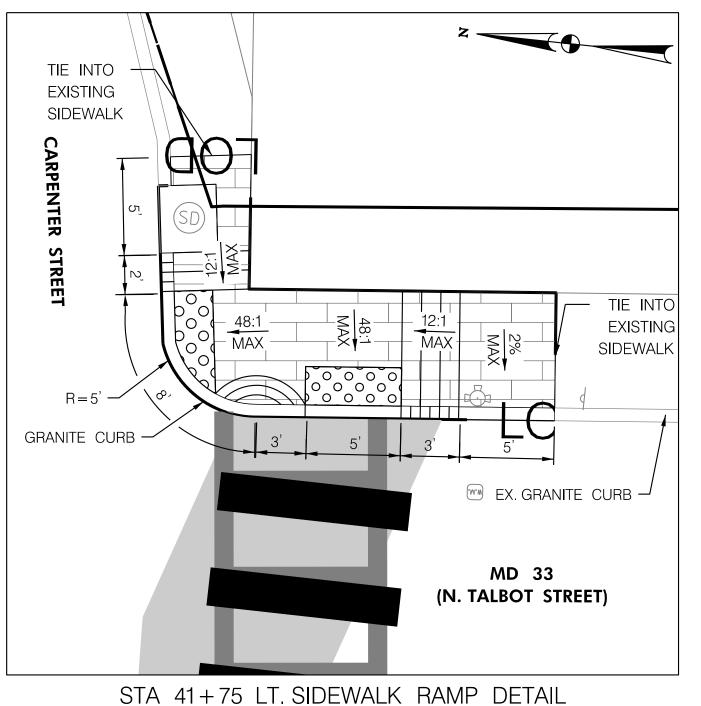

STA 41+75 LT. SIDEWALK RAMP DETAIL NOT TO SCALE

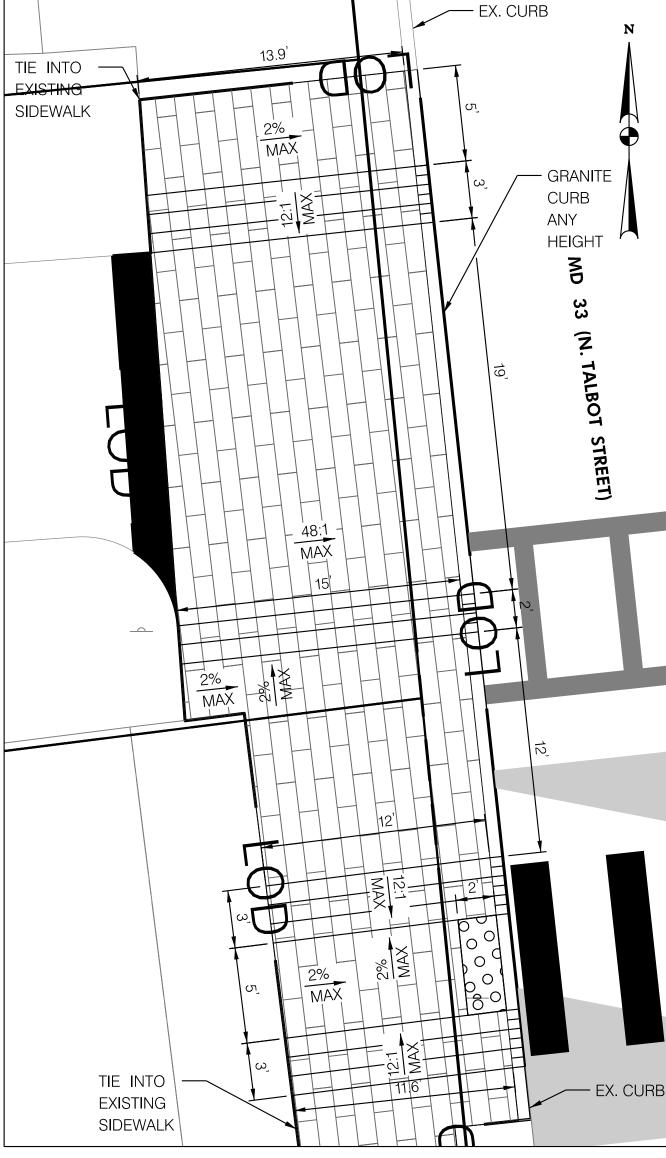

STA 43+35 RT. DRIVEWAY AND RAMP DETAIL NOT TO SCALE

MARYLAND DEPARTMENT OF TRANSPORTATION

STATE HIGHWAY

**ADMINISTRATION** 


INNOVATIVE CONTRACTING DIVISION

REPACEMENT AND REPAIR OF SIDEWALKS IN DISTRICT 2 AREA WIDE


MD 33 (TALBOT STREET) 200' NORTH

OF LEE STREET TO

150' SOUTH OF SPENCER DRIVE

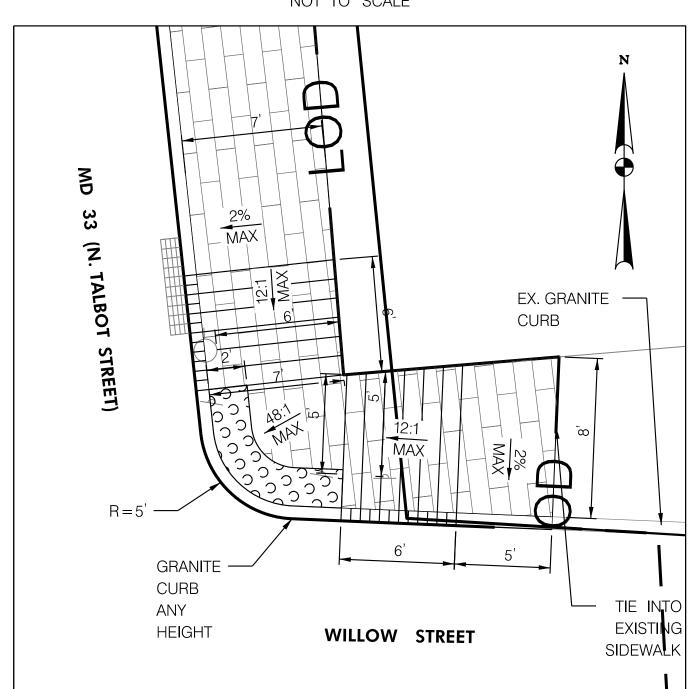



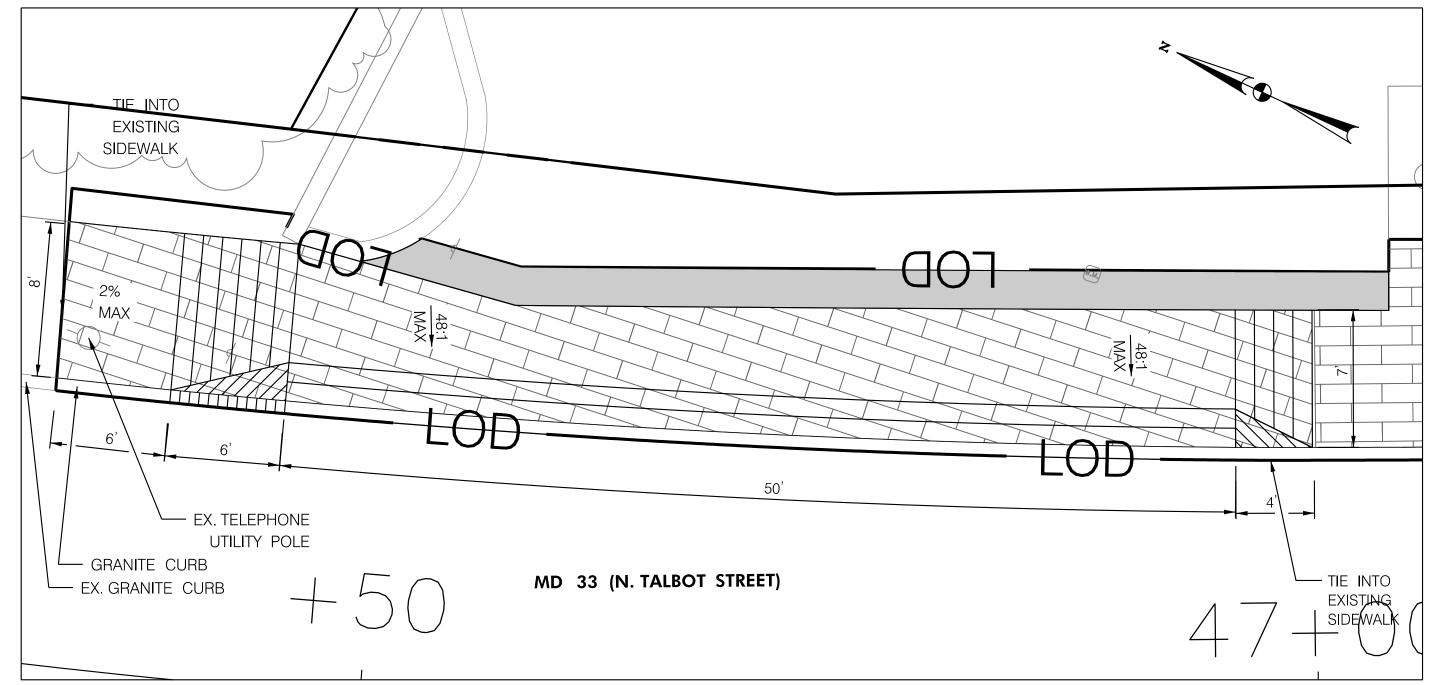


STA 46+75 LT. SIDEWALK RAMP DETAIL NOT TO SCALE

### NOTE TO CONTRACTOR:

- 1. ALL DISTURBED AREAS SHALL BE TEMPORARILY STABILIZED AT THE END OF EACH WORK DAY WITH TYPE 'E' SOIL STABILIZATION MATTING IN PERVIOUS AREAS OR GRADED AGGREGATE BASE COURSE IN IMPERVIOUS AREAS.
- 2. NO DISTURBED AREA SHALL BE LEFT UNSTABLIZED OVERNIGHT UNLESS THE RUNOFF IS DIRECTED TO AN MDE APPROVED SEDIMENT CONTROL DEVICE.
- 3. SEE GENERAL NOTES ON SHEET DE-01 FOR ADDITIONAL CONSTRUCTION NOTES FOR CURB RAMPS, SIDEWALKS, AND MEDIANS.
- 4. ALL TRANSITION SIDEWALK PANELS MUST BE CONSTRUCTED 5' MINIMUM OR TO THE NEXT EXISTING JOINT OR AS DIRECTED BY THE ENGINEER.

PAVEMENT LEGEND		R /W PLAT NUMBER	REVISIONS	SIDEWALK DETAIL SHEET		
BRICK SIDEWALK	CONCRETE SIDEWALK			SCALE AS SHOWN DATE MARCH 2020 CONTRACT NO. TA2295133		
STAMPED CONCRETE	CONCRETE DRIVEWAY ENTRANCE			DESIGNED BY AUO COUNTY TALBOT COUNTY		
SIDEWALK REMOVAL	DRIVEWAY TIE-IN			DRAWN BY         PNK         LOGMILE         12.852 TO 13.983           CHECKED BY         RJM         HORIZONTAL SCALE         N/A		
SIDEWALK RAMP	- LOD - LIMIT OF DISTURBANCE			MDE/PRD         17-PR-0056-04         VERTICAL SCALE         N/A		
DETECTABLE WARNING SURFACE	- CBCA - CHESAPEAKE BAY CRITICAL AREA			DRAWING NO. SD-04 OF SD-07 SHEET NO. 8 OF 26		

FILE: pw:\\shavmpwx.shacadd.ad.mdot.mdstate:SHAEDMS01\Documents\Areawide Projects\AW-ADA Sidewalks Design\Fund 33 Projects\District 2\MTA\Design Submittal No. 8 - MD 33 from Lee St to Spencer Dr\SHA In-house\Roadway\CAD\pSD-P004\_MD 33.dgn

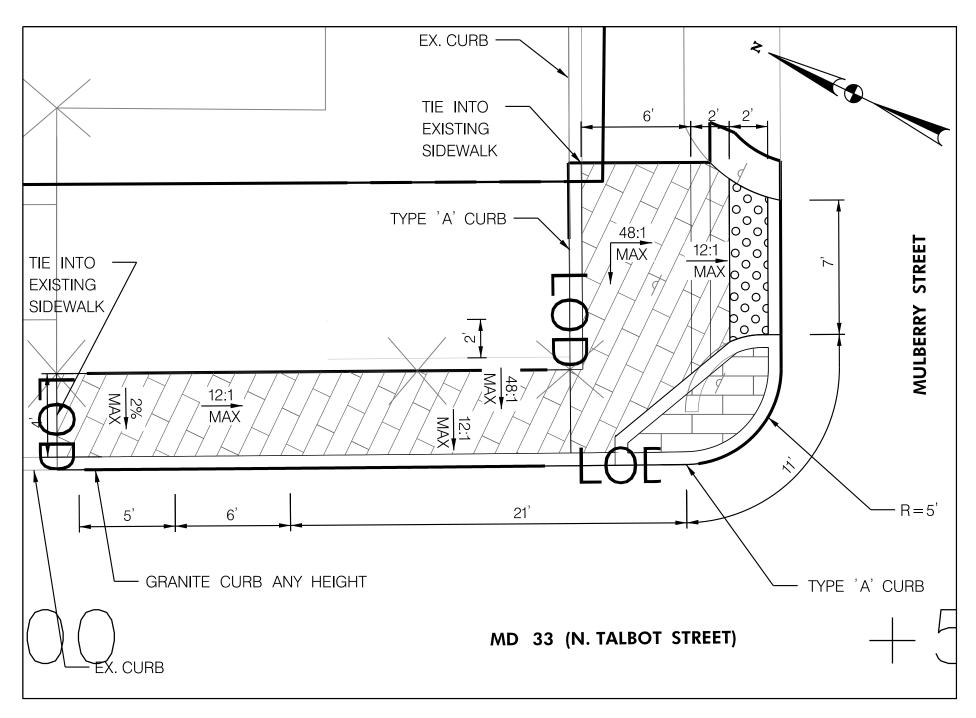

TIE INTO
EXISTING
SIDEWALK

5'

6'

RESET EX. W.M.
RESET EX. W.M.

ANY HEIGHT
EX. CURB AND GUTTER

MD 33 (N. TALBOT STREET)

MD 33 (N. TALBOT STREET)

EX. CURB

TIE INTO
EXISTING
SIDEWALK

SD

TO
TO
THE INTO
TO
THE


STA 52+28 RT. SIDEWALK RAMP DETAIL (ADA WAIVER LOCATION)


NOT TO SCALE

STA 48+06 LT. DRIVEWAY AND SIDEWALK RAMP DETAIL NOT TO SCALE

STA 49+74 LT. SIDEWALK RAMP DETAIL

NOT TO SCALE

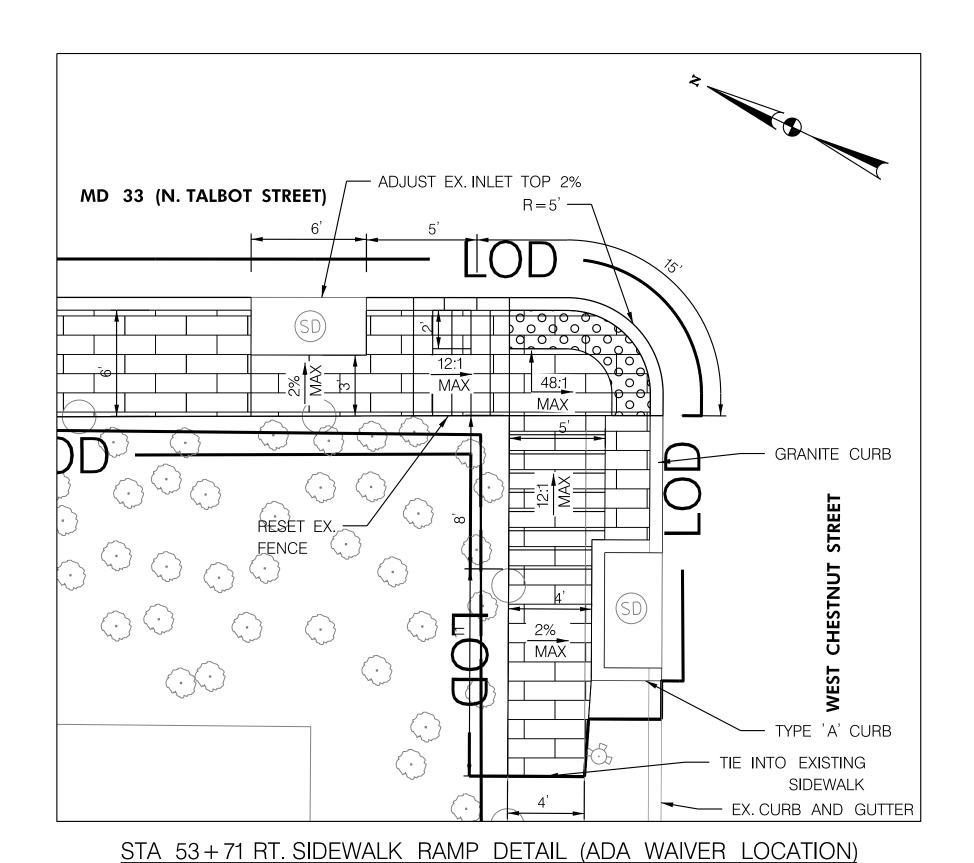

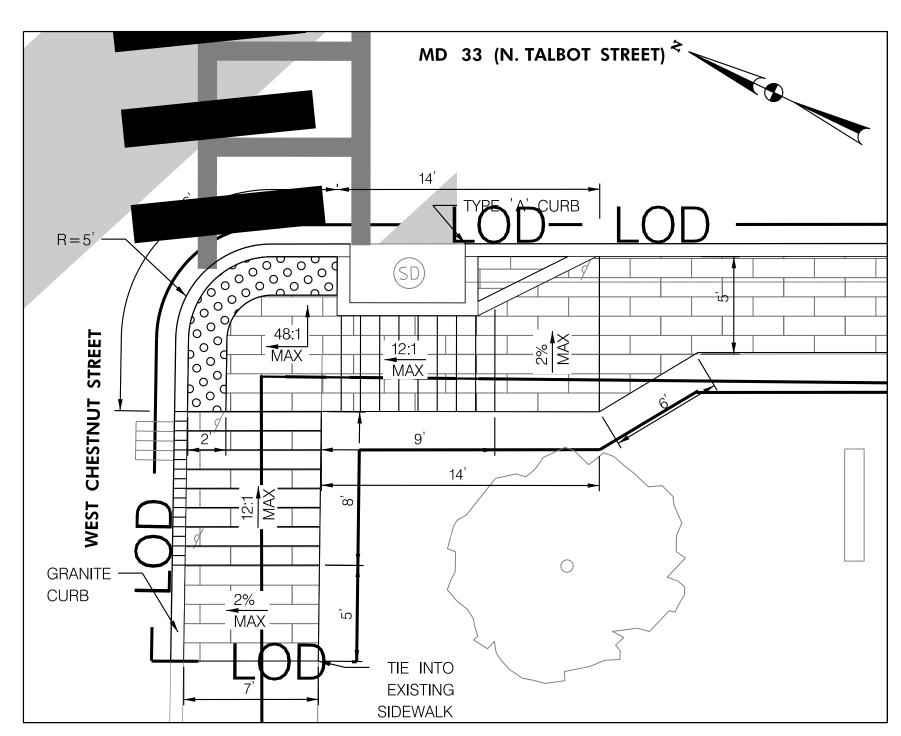

STA 54+28 RT. SIDEWALK RAMP DETAIL NOT TO SCALE

MARYLAND DEPARTMENT
OF TRANSPORTATION

STATE HIGHWAY
ADMINISTRATION

# INNOVATIVE CONTRACTING DIVISION

REPACEMENT AND REPAIR OF SIDEWALKS IN DISTRICT 2 AREA WIDE

MD 33 (TALBOT STREET) 200' NORTH
OF LEE STREET TO
150' SOUTH OF SPENCER DRIVE

#### NOTE TO CONTRACTOR:

NOT TO SCALE

- 1. ALL DISTURBED AREAS SHALL BE TEMPORARILY STABILIZED AT THE END OF EACH WORK DAY WITH TYPE 'E' SOIL STABILIZATION MATTING IN PERVIOUS AREAS.
- 2. NO DISTURBED AREA SHALL BE LEFT UNSTABLIZED OVERNIGHT UNLESS THE RUNOFF IS DIRECTED TO AN MDE APPROVED SEDIMENT CONTROL DEVICE.
- 3. SEE GENERAL NOTES ON SHEET DE-01 FOR ADDITIONAL CONSTRUCTION NOTES FOR CURB RAMPS, SIDEWALKS, AND MEDIANS.
- 4. ALL TRANSITION SIDEWALK PANELS MUST BE CONSTRUCTED 5' MINIMUM OR TO THE NEXT EXISTING JOINT OR AS DIRECTED BY THE ENGINEER.

PAVEMENT LEGEND		R /W PLAT NUMBER	REVISIONS	SIDEWALK DETAIL SHEET	
BRICK SIDEWALK	CONCRETE SIDEWALK			SCALE AS SHOWN DATE	E MARCH 2020 CONTRACT NO. TA2295133
STAMPED CONCRETE	CONCRETE DRIVEWAY ENTRANCE			DESIGNED BY AUO	COUNTY TALBOT COUNTY
	DRIVEWAY TIE-IN			DRAWN BY PNK  CHECKED BY RJM	LOGMILE 12.852 TO 13.983  HORIZONTAL SCALE N/A
	CHESAPEAKE BAY CRITICAL			MDE/PRD17-PR-0056-04	VERTICAL SCALEN/A
SURFACE = CBCA =	- CBCA - CHESAPEAKE BAY CRITICAL AREA			DRAWING NO. SD-05	5 OF SD-07 SHEET NO. 9 OF 26